
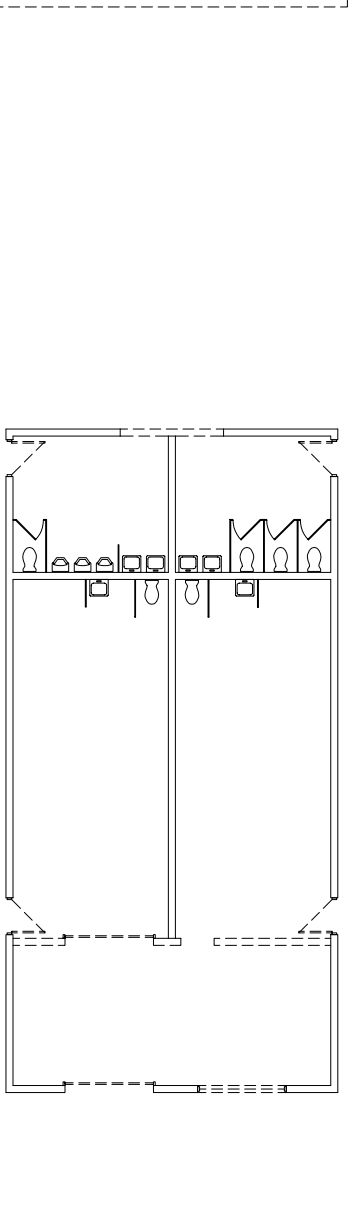
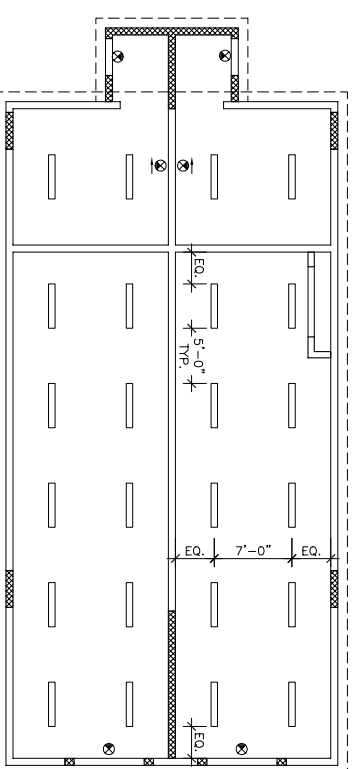
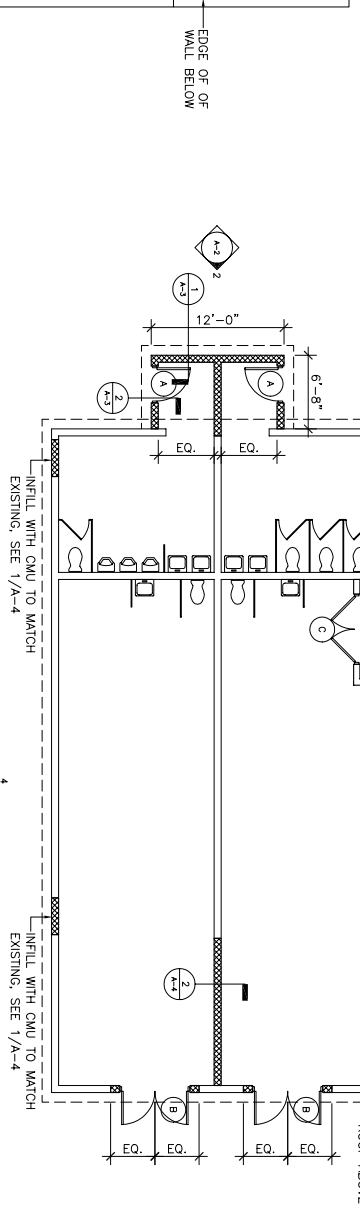


DEMOLITION LEGEND:	CONSTRUCTION LEGEND:
<p>EXISTING STRUCTURE OR FIXTURE TO REMAIN</p> <p>EXISTING STRUCTURE OR FIXTURE TO BE REMOVED</p> <p>EXISTING DOOR TO REMAIN</p> <p>EXISTING DOOR TO BE REMOVED</p>	<p>OFFICE</p> <p>ROOM NAME AND NO.</p> <p>EXISTING DOOR SWING TO REMAIN</p> <p>NEW DOOR SWING AND NO., SEE DOOR SCHEDULE A-3</p> <p>EXISTING WALL TO REMAIN</p> <p>NEW WALL</p> <p>INTERIOR ELEVATION e.g. ELEV. 1 ON DWG. A-6:1</p> <p>DETAIL TAG e.g. DETAIL 1 ON DWG. A-8</p>
<p>DEMOLITION NOTES:</p> <ol style="list-style-type: none"> CONTRACTOR TO FAMILIARIZE HIS/HERSELF WITH ALL EXISTING ELEMENTS OF CONSTRUCTION PRIOR TO COMMENCING DEMOLITION. ALL WORK SHALL COMPLY WITH ALL APPLICABLE REGULATIONS AND BE PERFORMED IN SUCH A MANNER AS TO ENSURE HUMAN SAFETY. CONTRACTOR TO COORDINATE THE REMOVAL AND RELOCATION OF ELECTRICAL AND MECHANICAL SYSTEMS AND DEVICES AS REQUIRED BY WALL DEMOLITION DAMAGE TO ADJACENT CONSTRUCTION TO REMAIN, A MANNER AS TO MINIMIZE DAMAGE. WHEN DEMOLITION OF ANY EXISTING ITEM IS IN QUESTION, NOTIFY ARCHITECT AND BUILDING MANAGER PRIOR TO DEMOLITION IN THE AREA. GO TO COORDINATE WITH BUILDING MANAGER ON SHUT-DOWN TIME WHEN WORKING IN AREAS WITH ADJACENT CONSTRUCTION. WHERE WALLS ARE REMOVED, THE GENERAL CONTRACTOR SHALL PATCH AND SAND SMOOTH AND HAVE WALL READY TO RECEIVE NEW FINISH. SALVAGE ITEM OF VALUE WHICH ARE NOT INDICATED TO BE RETURNED TO THE OWNER SHALL BE STORED IN A SECURE LOCATION, STORAGE OR OTHERWISE AS PERMITTED. EXPLOSIVES ARE NOT NECESSARY NOR PERMITTED. TRAFFIC: CONDUCT OPERATIONS AND REMOVAL OF DEBRIS TO ENSURE MINIMUM INTERFERENCE WITH THE NORMAL USE OF PUBLIC WAYS AND OTHER ADJACENT AREAS. ALL OPERATIONS SHALL BE CONDUCTED WITHIN THE PERMITS AND REGULATIONS OF THE LOCAL AUTHORITIES HAVING JURISDICTION. FIRE WATCH: PROVIDE A FIRE WATCH DURING ANY TORCH CUTTING PROCEDURES TO MONITOR FOR SPARKS AND OTHER HAZARDOUS CONDITIONS. REMOVED FOR DEMOLITION PURPOSES. CONTRACTOR SHALL PROVIDE A FIRE WATCH DURING ANY TORCH CUTTING PROCEDURES TO MONITOR FOR SPARKS AND OTHER HAZARDOUS CONDITIONS. TO AVOID CREATING A NUISANCE, SUFFICIENTLY WET CONSTRUCTION MATERIALS WITH FINE SPRAY OR SPRINKLING OF WATER DURING REMOVAL, CUTTING OR OTHER HANDLING SO AS TO REDUCE EMISSIONS, AEROSOLS, DUST, PRODUCING A NUISANCE TO ADJACENT AREAS. GENERAL CONTRACTOR AND TRADE CONTRACTORS MAY BE REQUIRED AT TIMES TO PROVIDE A NUISANCE CONTROL PROGRAM TO THE SATISFACTION OF THE OWNER. PRIOR TO THE START OF SELECTIVE DEMOLITION, THE GENERAL CONTRACTOR SHALL SUBMIT TO THE OWNER A NOISE CONTROL PROGRAM FOR REVIEW. 	<p>CONSTRUCTION NOTES:</p> <ol style="list-style-type: none"> ALL NEW WALLS TO BE CONSTRUCTION OF CMU ALL WORK SHALL CONFORM TO THE LATEST EDITION OF THE COMMONWEALTH REGULATION. ALL CONDUITS AND ITEMS FOR CLARIFICATION SHALL BE BROUGHT TO THE ATTENTION OF THE ARCHITECT PRIOR TO AFFECTING WORK IN THAT AREA. IF VARIANCE FROM THE EXISTING DRAWING OCCURS, NOTIFY THE ARCHITECT PRIOR TO COMMENCING ANY RELATED WORK. CONTRACTOR SHALL VISIT THE SITE PRIOR TO PREPARE THE DRAWINGS DEPICT THE EXISTING CONDITIONS AND PROVIDE THE ARCHITECT WITH A REPORT RESPONSIBLE FOR EXACT QUANTITY TAKE-OFFS BASED ON FIELD OBSERVATIONS. ALL PLAN DIMENSIONS INDICATED ARE TO FINISHED FACE OF WALL. U.O.N. CONTRACTOR SHALL FIELD VERIFY EXISTING CONDITIONS AND SHALL NOTIFY THE ARCHITECT IN WRITING OF ANY DISCREPANCIES AND/OR DAMAGED EXISTING BASE BUILDING WORK WHICH MAY INTERFERE WITH THE PROPER EXECUTION OF NEW WORK. NEW EXISTING WALLS INDICATED TO REMAIN, WHICH ARE DAMAGED DURING THE CONSTRUCTION OF NEW WORK, SHALL BE PATCHED AND REPAIRED BY THE CONTRACTOR TO MATCH ORIGINAL CONDITIONS. THE G.C. SHALL BE RESPONSIBLE FOR ALL MISSING GWS ON PERIMETER ABOVE & BELOW WINDOWS AND ALL COLUMNS.

CEILING LEGEND:	CEILING NOTES:																																																												
<p>EMERGENCY EXIT SIGNS - TO MATCH SCHOOL STANDARD</p> <p>INDUSTRIAL 4'-0" FLOURESCENT PENDENT DOWN LIGHT</p> <p>LINE METALWORK FINISHES W/ HIGH IMPACT CLEAR POLYCARBONATE EXAN LENS</p>	<ol style="list-style-type: none"> EXISTING CEILING TO REMAIN FINISH AS NECESSARY. REFERENCE ENGINEERING DRAWINGS FOR EXIT SIGN & STROBES. ARCHITECT SHALL APPROVE ALL MATERIALS AND FINISHES. ALL LAMPS SHALL HAVE THE SAME COLOR TEMPERATURE, GC & ELECTRICAL CONTRACTOR IS RESPONSIBLE FOR BRINGING ANY DISCREPANCIES IN THE CONSISTENCY OF LAMP TEMP. TO THE ATTENTION OF THE ARCHITECT. 																																																												
<p>HARDWARE SETS:</p> <p>SET 1 (SINGLE DOOR)</p> <p>-2 PAIR BB HINGES</p> <p>-LEVER LOCK SET</p> <p>"SCHLAGE" D-SERIES ATHENS ATCH. FINISH 626</p> <p>-ADJ COMPLIANT DOOR CLOSER W/ FINISH 626</p> <p>-FLOOR STOP</p> <p>"VES" DOME, FINISH US260</p> <p>NOTE: G.C. TO COORDINATE KEVING WITH SCHOOL. ALL LOCKS TO BE KEVED OFF A MASTER KEY.</p>	<p>SET 2 (DOUBLE DOOR)</p> <p>-4 PAIR BB HINGES</p> <p>-LEVER LOCK SET</p> <p>"SCHLAGE" D-SERIES ATHENS ATCH. FINISH 626</p> <p>-8) SILencers BLACK</p> <p>-ADJ COMPLIANT DOOR CLOSER W/ FINISH 626</p> <p>-FLOOR STOP</p> <p>"VES" DOME, FINISH US260</p>																																																												
<p>DOOR AND FRAME SCHEDULE</p> <table border="1"> <thead> <tr> <th>NUMBER</th> <th>TYPE</th> <th>MATL</th> <th>SIZE</th> <th>WD/HGT</th> <th>THK</th> <th>FINISH</th> <th>UNDERCUT</th> <th>RATING</th> <th>HARDWARE</th> <th>TYPE</th> <th>MATL</th> <th>FINISH</th> <th>DETAIL</th> <th>REMARKS</th> </tr> </thead> <tbody> <tr> <td>A</td> <td>A</td> <td>MTL</td> <td>3'-0" x 7'-10"</td> <td>1 3/4"</td> <td>PAINT</td> <td>-</td> <td>-</td> <td>-</td> <td>1</td> <td>A</td> <td>H.M.</td> <td>P2</td> <td>4/1/4-4</td> <td>3/1/4-4</td> </tr> <tr> <td>B</td> <td>B</td> <td>MTL</td> <td>6'-0" x 7'-8"</td> <td>1 3/4"</td> <td>PAINT</td> <td>-</td> <td>-</td> <td>-</td> <td>2</td> <td>B</td> <td>H.M.</td> <td>P2</td> <td>4/1/4-4</td> <td>3/1/4-4</td> </tr> <tr> <td>C</td> <td>B</td> <td>MTL</td> <td>6'-0" x 7'-8"</td> <td>1 3/4"</td> <td>PAINT</td> <td>-</td> <td>-</td> <td>-</td> <td>2</td> <td>C</td> <td>H.M.</td> <td>P2</td> <td>4/1/4-4</td> <td>3/1/4-4</td> </tr> </tbody> </table>	NUMBER	TYPE	MATL	SIZE	WD/HGT	THK	FINISH	UNDERCUT	RATING	HARDWARE	TYPE	MATL	FINISH	DETAIL	REMARKS	A	A	MTL	3'-0" x 7'-10"	1 3/4"	PAINT	-	-	-	1	A	H.M.	P2	4/1/4-4	3/1/4-4	B	B	MTL	6'-0" x 7'-8"	1 3/4"	PAINT	-	-	-	2	B	H.M.	P2	4/1/4-4	3/1/4-4	C	B	MTL	6'-0" x 7'-8"	1 3/4"	PAINT	-	-	-	2	C	H.M.	P2	4/1/4-4	3/1/4-4	<p>DOOR & FRAME DIMENSIONS & DETAILS:</p>
NUMBER	TYPE	MATL	SIZE	WD/HGT	THK	FINISH	UNDERCUT	RATING	HARDWARE	TYPE	MATL	FINISH	DETAIL	REMARKS																																															
A	A	MTL	3'-0" x 7'-10"	1 3/4"	PAINT	-	-	-	1	A	H.M.	P2	4/1/4-4	3/1/4-4																																															
B	B	MTL	6'-0" x 7'-8"	1 3/4"	PAINT	-	-	-	2	B	H.M.	P2	4/1/4-4	3/1/4-4																																															
C	B	MTL	6'-0" x 7'-8"	1 3/4"	PAINT	-	-	-	2	C	H.M.	P2	4/1/4-4	3/1/4-4																																															

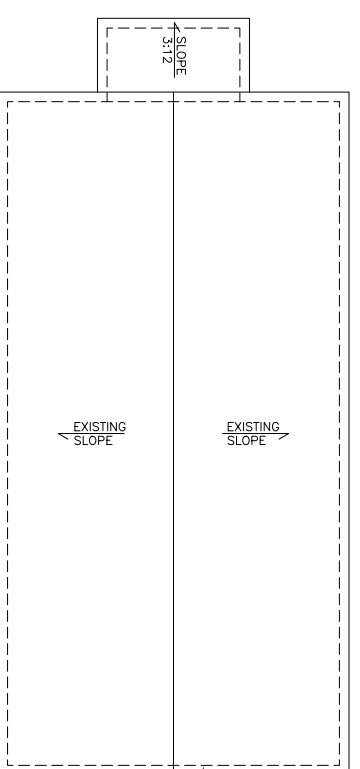

NO.	DATE	REVISION

PROJECT **ANDOVER HIGH SCHOOL GOLDEN WARRIORS ATHLETIC FIELD LOCKER ROOM IMPROVEMENTS**

ANDOVER, MA

162 COLUMBUS AVENUE - 3RD FLOOR
BOSTON, MASSACHUSETTS 02116
PH: 617.457.0990 FX: 617.457.0988

TITLE **DEMOLITION, ARCHITECTURAL & ROOF PLANS AND NOTES**

SCALE 1/8" = 1'-0" PROJECT NO. 04141

DATE DRWN BTW CHKD RMC

DRAWING NO. **A-1**